
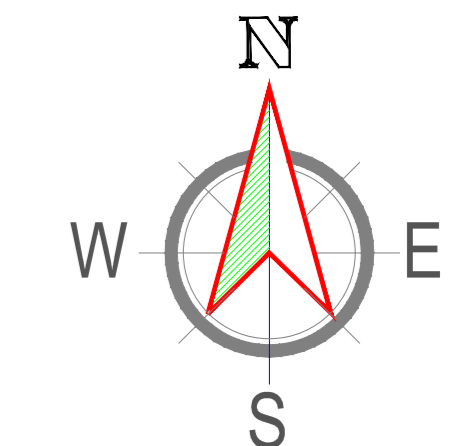


FIGURE 4.1
DESIGN EVOLUTION (MARCH 2021)

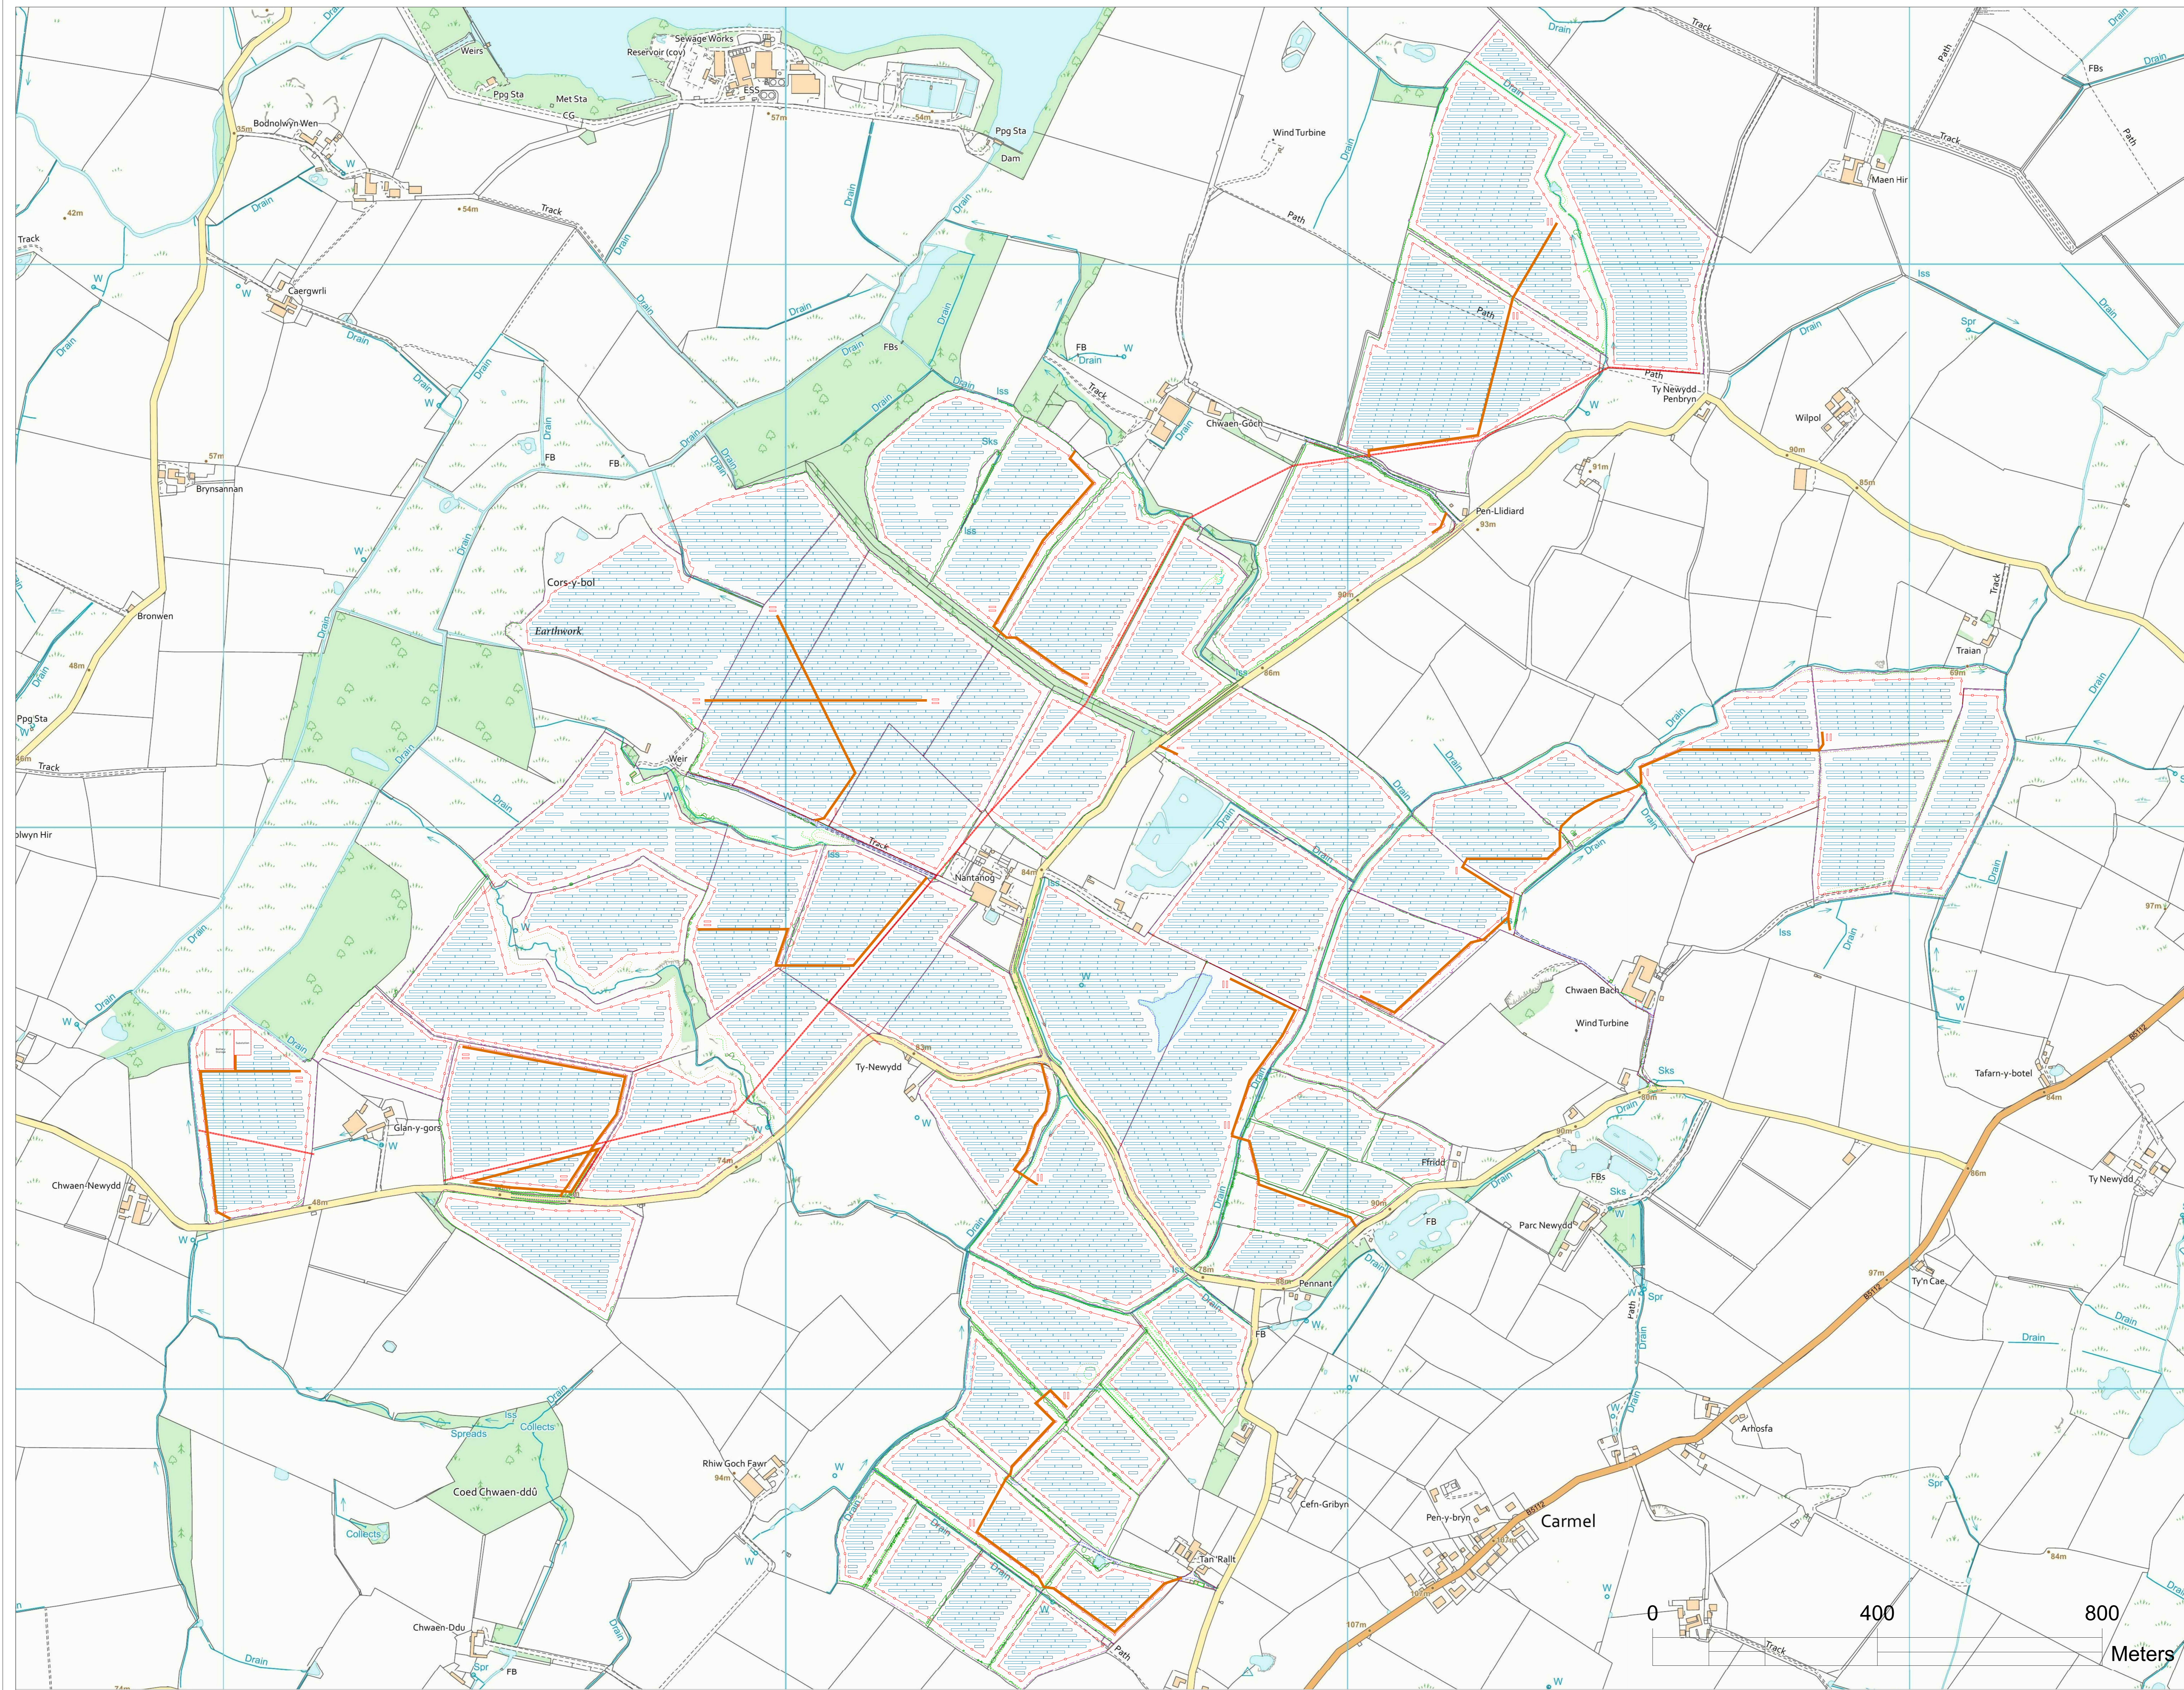

GENERAL NOTES

1. MODULE TYPE: 540 Wp ; BIFACIAL MODULE.
2. MODULE QTY : :xx,xxx.
3. DC CAPACITY: 156,000kWp.
4. PITCH: VARIES WITH TOPOGRAPHY
5. COORDINATES: 53.326, -4.427.

LEGEND

- PV MODULE
- PERIMETER FENCE
- PROPOSED ROAD
- PUBLIC RIGHT OF WAY
- OVERHEAD LINE TOWERS
- OVERHEAD LINES
- GAS MAIN
- REDLINE
- INVERTER STATION

REFERENCE DRAWINGS

No.	DRAWING TITLE	DRAWING No.

R	DATE	DESCRIPTION OF REVISION	REMARKS
04	26-03-2021	Added substation location	
03	18-03-2021	Added preliminary road and inverter locations	

PROJECT NAME : **ALAW MON SOLAR PV AND BATTERY**

OWNER'S ENGINEER :

GENERAL CONTRACTOR :



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DRAWN BY : GM	SIGN :	TITLE : PROPOSED SITE PLAN
DATE : 26-03-2021		
CHECKED BY :		
DATE :		
APPROVED BY :		
DATE :		
DRAWING No. : WY2.0		

SHEET SIZE : A0	SHEET : 1 OF 1	SCALE : 1:4000	REV : 04
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